
BIRCH LAKE DUPLEX

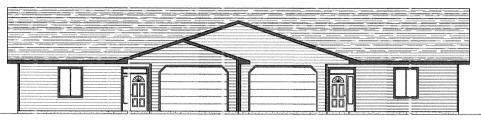

FRONT ELEVATION

WOOD DECK WOOD DECK 18'-0"x 12'-0" 18'-0" x 12'-0" LIVING AREA LIVING AREA MASTER MASTER BEDROOM BEDROOM 15'-4" x 12'-0" 15'-4" > 12'-0" DINING 00 DINING AREA 9-3" x 8-0" AREA M. BATH KITCHEN 11'-10" x 9'-10" 12'-3" x 8'-6" KITCHEN 15'0" x 9'-10" BEDROOM #2 BEDROOM #2 GARAGE 15'-1" x 27'-1" GARAGE 15'4"x 29'4" SIDE WALK FLOOR PLAN

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PO BOX 521152 BIG LAKE ALASKA 99652

Jim Faiks

BIRCH LAKE DUPLEX COVER PAGE AND SHEET INDEX

DATE: SCALE: 01-08-16 AS SHOW

GEN. G1.0 SHEET NO: 01 or 09

"D" (22" x 34")

DRAWING SCALE VALID ONLY WHEN PLOTTED TO ORIGINAL DRAWING SIZE AS SHOWN IN TITLE BLOCK

SQUARE FOOTAGE:

LIVING AREA = 1,345 SQ. FT. GARAGE AREA = 469 SQ. FT.

RIGHT UNIT: LIVING AREA = 1,345 SQ. FT.

GARAGE AREA RIGHT = 437 SQ. F".

SHEET INDEX

1	DWG NO.	DRAWING TITLE
	G1.0	COVER PAGE AND SHEET INDEX
	G2.0	GENERAL NOTES, FIREWALL DETAIL

S1.0 FOUNDATION PLAN

\$2.0 ROOF LAYOUT \$3.0 BUILDING SECTION

A1.0 FLOOR PLAN

FRONT AND REAR ELEVATIONS A2.0 A2.1 RIGHT AND LEFT ELEVATIONS


E1.0 ELECTRICAL LAYOUT

ABBREVIATIONS

ABOVE FINISHED FLOOR MECHANICAL MED MIN NFS OC AMERICAN PLYWOOD ASSOCIAT ON MECIUM MIN MUM ALL WEATHER WOOD CASEMENT NON FROST SUSCEPTIBLE DOUBLE CASEMENT CUIII CONCRETE MASONRY UNIT ORIENTED STRAND BOARD OSB CF'C ELEV CASEMENT, PICTURE, CASEMENT ELEVATION PICTURE (FIXED) P PRIV EMBED EMBEDMENT EXT EXTERIOR FF: FIRE RATED SLIDER SOL D CORE S SC SCRN SP TH TOF TOS TOW TYP UNO VER VIF W SCHEEN SPEAKER THICK
TOP OF FLOOR (SUB FLOOR)
TOP OF SLAB
TOP OF WALL (TOP PLATE) GROUND FAULT CIRCUIT INTERRUPTER GECL GYPSUM WALL BOARD HEIGHT H9H HOSE BIB HEAD BOLT HEATER TYPICAL HOLLOW CORE HORIZONTAL UNLESS NOTED OTHERWISE VERTICAL VEP:IFY IN FIELD INSUL INSULATED INT MATL WIETH WATER PROOF MATERIAL



DOOR SPECIFICATIONS G2.0 SCALE: NTS

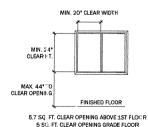

EGRESS INSTALLATION



DH = DOUBLE HUNG P = PICTURE (FIXED) **WINDOW**

ABBREVIATIONS

WINDOW SPECIFICATIONS Q WIND

G2.0 | SCALE: 1"-1'0"

DRAFTER ASSUMES NO RESPONSIBILITY OR LIABILITY FOR THE ACCURACY AND DESIGN OF THESE DRAWINGS, ALL DESIGN INFORMATION AND MEASUREMENTS WERE SUPPLIED AND CHECKED BY TO BE CONSTRUCTED IN ACCORDANCE WITH

NOTES:

- 1. CE LINGS TO BE 9' THROUGH OUT ENT RE BUILDING.
- 2. WINDOWS IN LIVING AREA TO BE 2'-0" FROM FINISH FLOOR.
- 3. STUB GAS IN FOR RANGE AND CORNER FIREPLACE (EACH UNIT).
- HCSE BIB INSTALLED EACH UNIT (OUTSIDE MASTER BATH).

THE OWNER OR HIS/HER REPRESENTATIVE. BUILDING INTERNATIONAL BUILDING CODE SPECIFICATION.

SPAN RATED SHEATHING TRUSS (SHOWN FOR VISUAL PURPOSES ONLY - NOT ACTI AL SIZE / SHAPE) ONE (1) LAYER OF § GWB EACH SIDE ONE (1) LAYER OF § GWB EACH SIDE OF 2" x 4" STU D WALL 2"x4" (2) TOP PLATE RESILIENT CHANNEL (OWNER SPECIFIED - TYP.1 ACOUSTIC BATT INSULATION 3" OSB SHEATHING FOR SHEAR 2" x 4" STUD WALL 1" AIR GAP 2" x 4" TREATED SIL., PLATE 4º MONOSLAB TWO (2) #5 REBAR 3* COVER (TYP.) 16" x 18" THICK : NED FOOTER

FIREWALL SECTION

DRAWING SCALE VALID ONLY WHEN PLOTTED TO ORIGINAL DRAWING SIZE AS SHOWN IN TITLE BLOCK


PO BOX 521152 31G LAKE ALASKA 99652 Jim Faiks


BIRCH LAKE DUPLEX GENERAL NOTES AND FIREWALL DETAIL


DATE: 01-08-16 SCALE: AS SHOW DRWN BY: MPD


DISCIPLINE GEN. G2.0 SHEET NO: 02 of 09

"D" (22" x 34")

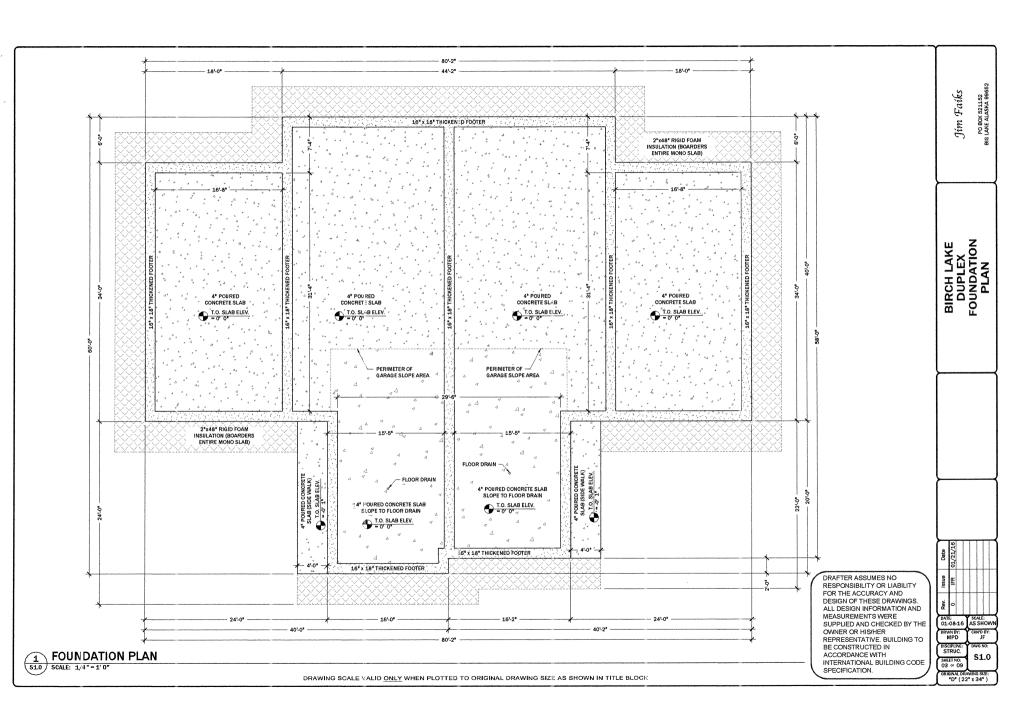


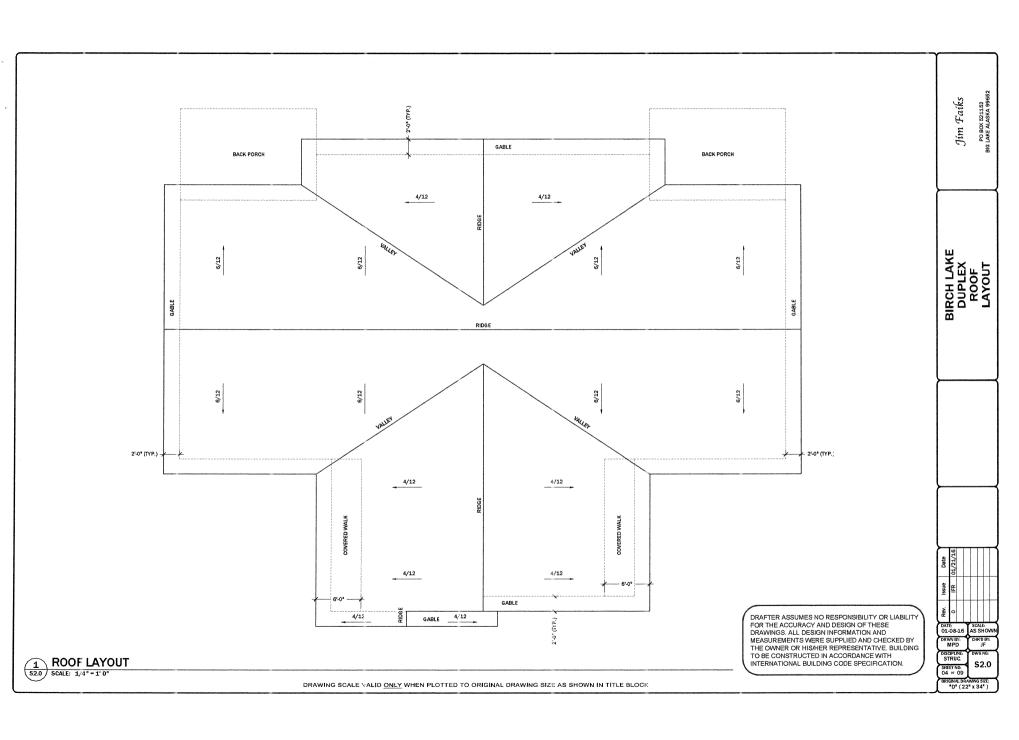

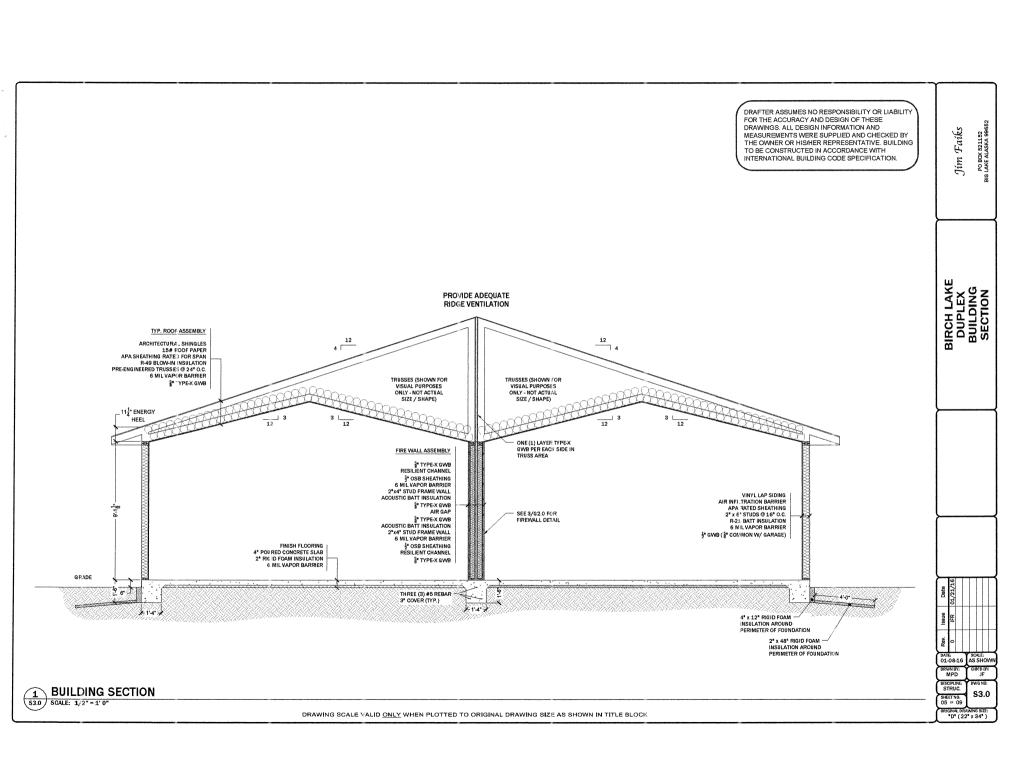


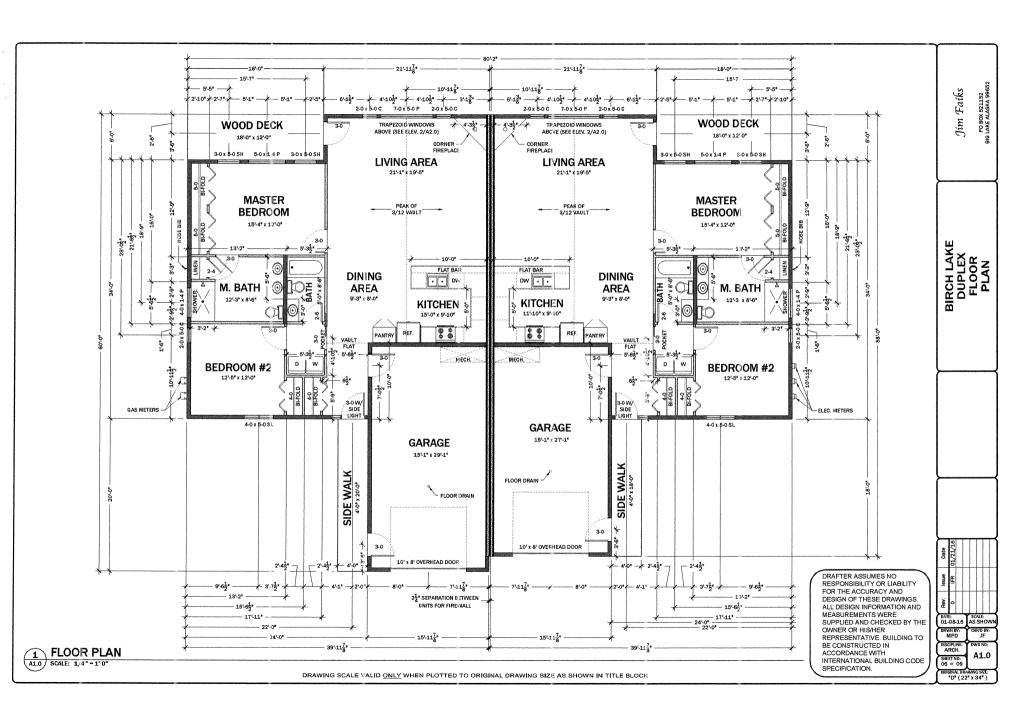


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FRONT ELEVATION
SGALE: 1/4"-1'0"

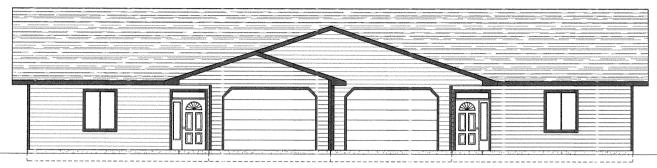

TRAP. WINDOW DETAIL

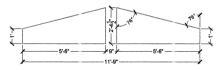

REAR ELEVATION
A2.0 SCALE: 1/4" - 1'0"

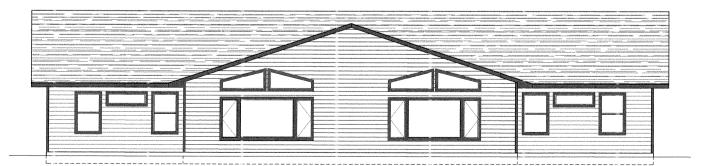DRAWING SCALE VALID ONLY WHEN PLOTTED TO ORIGINAL DRAWING SIZE AS SHOWN IN TITLE BLOCK

PO BOX 521152 BIG LAKE ALASKA 99652 Jim Faiks

BIRCH LAKE DUPLEX FRONT AND REAR ELEVATIONS

DATE: 01-08-16

DISCIPLINE: ARCH.

DRAFTER ASSUMES NO RESPONSIBILITY OR LIABILITY FOR THE ACCURACY AND DESIGN OF THESE DRAWINGS. ALL DESIGN INFORMATION AND MEASUREMENTS WERE SUPPLIED AND CHECKED BY THE OWNER OR HIS/HER REPRESENTATIVE. BUILDING TO BE CONSTRUCTED IN ACCORDANCE WITH INTERNATIONAL BUILDING CODE SPECIFICATION.


PO BOX 521152 BIG LAKE ALASKA 99652 Jim Faiks

BIRCH LAKE DUPLEX RIGHT AND LEFT ELEVATIONS

- ELECTRIC METERS

RIGHT ELEVATION

SCALE: 1/4" - 1'0"

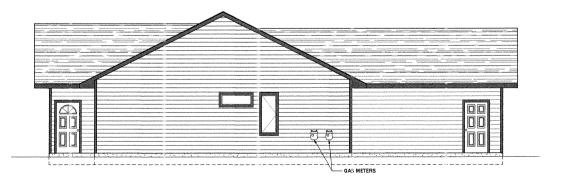

2 LEFT ELEVATION
SCALE: 1/4" - 1'0"

DRAWING SCALE VALID ONLY WHEN PLOTTED TO ORIGINAL DRAWING SIZE AS SHOWN IN TITLE BLOCK

DRWN BY: MPD

ORIGINAL DRAWING SIZE: "D" (22" x 34")

